

TOWER 4
2TH,4TH,6TH,8TH,10TH & 12TH FLOOR

TOWER 4
ROOF PLAN

PROJECT
ADDITION ALTERATION OF PROPOSED G+12,G+18 AFFORDABLE HOUSING UNDER PRADHAN MANTRI AWAS YOJANA & G+28 STORIED BUILDINGAT PRE. NO.39/1 SHALIMAR ROAD, MOUZA SHIBPUR SHEET NO.170,9,15,17, L.R. DAG NO. 12,13,39,40,41,42,44,45, 60,61,62,63,6,7,8,9,10,11,12,13,14,15,16,17,21,22, 24,1,2,11 P.S-SHIBPUR, WARD NO-39, BOROUGH -VI,DIST HOWRAH-711103, UNDER HOWRAH MUNICIPAL CORPORATION.WEST BENGAL, PREVIOUSLY SANCTIONED VIDE BRC NO. 358/19-20 DATED 4.02.2020

TITLE :
 TYPICAL FL (2ND,4TH,6TH,8TH,10TH & 12TH FL.) & ROOF (TOWER-4 AND TOWER-3,WHICH IS MIRROR OF TOWER-4)

SCHEDULE OF DOORS & WINDOWS

DOORS	NO.	WIDTH	HEIGHT	TYPE	WINDOWS	NO.	WIDTH	HEIGHT
D1	1000	2100	W1	1000	1200			
D2	900	2100	W2	1500	1200			
D3	750	2100	W3	1800	1200			
D4	2000	2100	W4	1200	1200			
D5	1500	2100	W5	900	1950			
F.C.D	1000	2100	W6	900	1100			
SD1	2100	2100	W7	600	900			
SD2	2500	2100	W8	750	900			
SD3	3000	2100	W9	1000	900			
CG1	5000	2100						
CG2	2500	2100						

- SPECIFICATION**
- 1ST CLASS CEMENT BRICK WORK IN SUPERSTRUCTURE
 - 200 THK. EXT. BRICK WALL & 100 THK. INT. BRICK WALL IN 1:4 CEMENT MORTAR
 - LEAN CONC. (1:3) WITH 10 MM. DOWN GRADED STONE CHIPS FOR ALL P.C.C. WORKS
 - M-25 CONC. (1:2) FOR ALL R.C.C. WORKS
 - 20 MM. & 15 MM. THK. PLASTER (1:5) ON EXT. & INT. BRICK WALL RESPECTIVELY & 10 MM. THK. PLASTER (1:3) ON CEILING
 - 20 X 40 FLAT ORNAMENTAL GRILL WITH WINDOW FRAME & 40 MM. THK. MARBLE FLOORING INCLUDING SKIRTING OVER R.C.C. FLOOR SLAB
 - SINGLE LAYER F.S.S. IN FOUNDATION & JAMB
 - WIRE & LACQUER FOR SHUTTERING & LABOR WORKS INCLUDING STOUT PROPS TO BE PLACED AS PER DIRECTION
 - TOR STEEL BAR FOR ALL R.C.C. WORKS INCLUDING DISTRIBUTORS & BINDERS
 - SANITARY & PLUMBING FITTING & FIXING COMPLETE AS PER SILE
 - MATERIALS TO BE USED: CEMENT- PORTLAND, SAND- MEDIUM COARSE, STONE CHIPS- 19 MM. DOWN GRADED
 - CLEAR COVER TO MAIN REIN. FOUNDATION- 50 MM., COLUMN- 40 MM., BEAM- 25 MM., SLAB- 20 MM.
 - SAL WOOD TO BE USED FOR DOOR & WINDOW FRAME & TEAK WOOD FOR SHUTTERS
 - ALL DIMENSIONS ARE IN MM. UNLESS OTHERWISE MENTIONED & WRITTEN DIMENSIONS WILL SUPERCEED MEASURED DIMENSIONS

DECLARATION
 THE PLOT IS BOUND & BOUNDED BY BOUNDARY WALL. THE CHARACTER OF THE ROAD IS A H.M.C. ROAD. I DO HEREBY DECLARE WITH FULL RESPONSIBILITY THAT THE BUILDING PLAN HAS BEEN DRAWN BY ME AS PER PROVISION OF H.M.C. BUILDING RULES-2008 AS EXTENDED MUTATIS MUTANDIS TO H.M.C. AND THE SITE CONDITION INCLUDING THE WIDTH OF THE ABUTTING ROAD CONFIRM WITH THE SITE PLAN AND THAT IS BUILDABLE SITE AND NOT A TANK OR FILLED UP LAND.

SIGNATURE OF APPLICANT
 [Signature]
 CONSULTANT ARCHITECT

SIGNATURE OF ARCHITECT
 [Signature]
 ARCHITECT

DECLARATION
 I CERTIFY THAT THE FOUNDATION AND THE SUPER STRUCTURE OF THE BUILDING HAVE BEEN SO DESIGNED BY ME THAT IT IS SAFE IN ALL RESPECT INCLUDING IN THE CONSIDERATION OF THE BEARING CAPACITY & SETTLEMENT OF SOIL.
 I CERTIFY THAT THE STRUCTURAL DESIGN & DRAWING OF BOTH FOUNDATION AND SUPER STRUCTURE OF THE BUILDING HAS BEEN DESIGNED BY ME CONSIDERING ALL POSSIBLE LOADS (HORIZONTAL & VERTICAL) AS PER THE NATIONAL BUILDING CODE OF INDIA.

SIGNATURE OF STRUCTURAL ENGINEER
 [Signature]
 STRUCTURAL ENGINEER

ALLOTMENT
 Registered Geotechnical Engineer
 Kolkata Municipal Corporation
 Class-I, No-G/11/11
 6A, Milan Park
 700014, Kolkata

SIGNATURE OF GEOTECHNICAL ENGINEER
 [Signature]
 GEOTECHNICAL ENGINEER

UNDERTAKING


- 1) I/ WE UNDERTAKE THAT WHEN THE SEWER LINE WILL BE AVAILABLE, I/ WE SHALL TAKE CONNECTION AT MY OWN COST & AS PER RULE.
- 2) NO BUILDING MATERIALS WILL BE STACKED / DEPOSITED ON ROAD OVERNIGHT.
- 3) I/ WE SHALL ARRANGE FOR RAISING & MAINTENANCE OF TREE AS SHOWN IN THE DRAWING AT MY OWN COST.

SCALE 1:100 **REF. NO.** **DATE** 10.9.2023 **DWG. NO.** ESP/2019/SHALIMAR/SAN/ARCH-4-02

SCALE **DATE** **PROJECT** **DESIGNED** **DATE**

SPACE
 3/A, B, SHARAT BANERJEE ROAD,
 KOLKATA 700 028
 PH:88-2485-4158

THIS DRAWING IS A PROPERTY OF SPACE, 3/A, SHARAT BANERJEE ROAD, KOLKATA-700028. ANY MODIFICATION, CHANGES, DEVIATIONS IS NOT PERMISSIBLE WITHOUT PRIOR INTIMATION TO SPACE IN THE COUNTRY. THIS WILL BE TREATED AS LEGAL ACT.

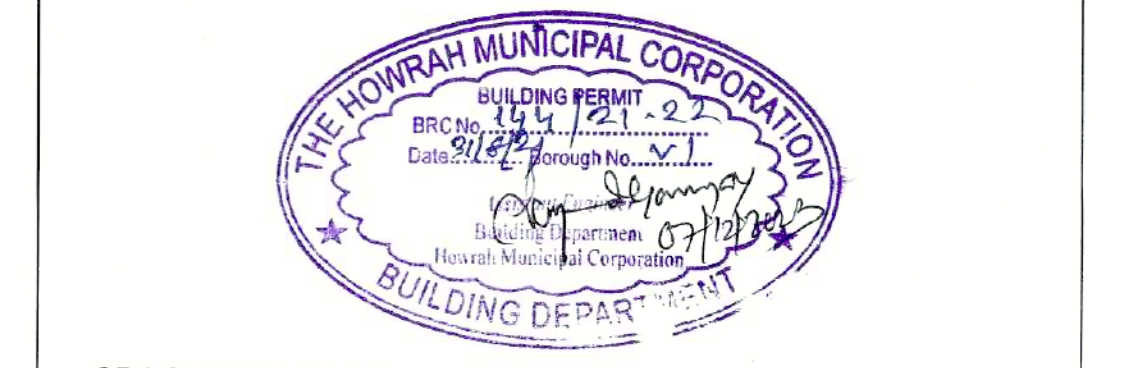

SPACE FOR H.M.C.

APPLICANT HAS TO EXHIBIT AT A CONSPICUOUS PLACE:
PERMITS NO. :-
NAME OF THE I.P.A. LIA.
NAME OF THE STRUCTURAL ENGRG.
NAME OF THE CIVIL ENGINEER
NAME OF OWNER :-
NAME OF THE APPLICANT :-
BUILDING PERMIT

THE SANCTION IS VALID
UP TO 20/11/2025

APPROVED AS PER
COMMISSIONING OF 20/11/25

APPLICANT SHALL KEEP AT THE SITE ONE SET
OF PLANS AND SPECIFICATIONS AND SHALL
EXHIBIT A CONSPICUOUS PLACE THE NUMBER
OF THE PERMIT. THE NAME OF THE ARCHITECT
OR LICENSED BUILDING SURVEYOR, STRUCTURAL
ENGINEER AND CIVIL ENGINEER
NAME OF OWNER AND NUMBER AND DATE OF
THE BUILDING PERMIT.

CONSTRUCTION SITE SHALL
MAINTAIN TO PREVENT
WORMS OR BREEDING IN ALL
WATERBODIES SO THAT ALL WATERS
COLLECTION & PARTICULARLY
WELLS, VATS, BASEMENT CURBS,
PITS, OPEN RECEPTACLES ETC.
MUST BE EMPTIED COMPLETELY
AT REGULAR INTERVALS.

Sanctioned Conditionally on
undertaking from the owner
that if any part of the building
to be constructed falls within
the alignment of HMC, the
same will be demolished by
the owner at his/her risk and
for this the owner will not claim
any compensation from HMC.

Plans for water connection arrangement
SEMI U. G. should be submitted at the
Office of the Assistant Engineer of
Borough and sanction to be obtained
before proceeding with the work of
Water Supply. Any deviation may lead to
disconnection / demolition.

No rain water pipe should be fixed or
discharged on Road or Footpath.
Drainage plan should be submitted
at the Borough Assistant Engineer's
Office and the sanction obtained before
proceeding with the drainage work.

PLACED IN MUNICIPAL
BUILDING COMMITTEE
DATE: 18/11/25

PARTY'S COPY



Structural plan and design calculation as submitted by the
structural engineer, have been kept with B.R.
No. 117/25. The date of submission of the
records of the Powrah Municipal Corporation without
verification. Non-compliance from the submitted structural plan
should be taken care of during erection without submitting
fresh structural plan along with design calculation and
stability calculation. The prescribed term, necessary steps
should be taken to ensure the safety of the adjoining premises
public and private properties during the construction of the
building during construction.

Construction subject to demerit of
building which is not in compliance
as per plan before construction is
started.

Before starting any construction
site must conform with the
sanctioned and all the conditions
preposed in the plan should be fulfilled.

The validity of the written permits
to execute the work is subject to
above conditions.

The Building Materials necessary for
construction should conform to
standard specified in the National
Building Code of India.

Design of all structural members
including that of the foundation
should conform to Standards
specified in the National Building
Code of India.

Non-Commencement of Erection /
Re-Erection within Two Year
will Require Fresh Application for
Sanction.

RESIDENTIAL BUILDING

DEVIATION WOULD MEAN DEMOLITION

Necessary steps should be taken for
the safety of the lives of the adjoining
public and private properties during
construction. Also to avoid pollution as
per WPPCB Guidelines in Vague.

CORRECTION PLAN 97
B.C. No. 117/25
Date: 18/11/25
Sub. Asst. Engineer
Bldg. Department
Powrah Municipal Corporation

Tower-G
Section X-X
Section Y-Y